<u>CITY OF ONEONTA</u> <u>SITE PLAN REVIEW APPLICATION</u>

THE COMPLETED APPLICATION, FEE, AND ALL REQUIRED DOCUMENTS MUST BE SUBMITTED TO THE CODE ENFORCEMENT OFFICE AT LEAST THREE (3) WEEKS BEFORE THE SCHEDULED MEETING IN ORDER TO BE INCLUDED ON THE AGENDA.

Code Enforcement Office 258 Main Street Oneonta, New York 138 607-433-3435 607-432-0945 (fax) codeenforcement@oneon www.oneonta.ny.us/code Application Purpose: Addition to Existing B Construct New Building	ata.ny.us (email) cenforcment uilding Parking Waiver	Application Fee: Received By: Date Received: Demolition Other	\$ 75.00
Property Address:	(LEW15-STREET) One (1) Property Per Application		
Business Name:	U.S. BUILDING PR	ODUCTS	
Applicant's Name:	JAY SHULTIS		
Day Phone:	540, 250, 2320		
Email Address:	jay e usbuilding produ		
Mailing Address:	33 Walnut str	eet	
	Oneonta	HY	13920
Signature Date:	City 7/2/2015	State	- th
Signature:	Luk. Margli	ever c/o Ja	y Shultes
Property Owner's Name:	Jay SHULTIS		
Day Phone:	540.250.232	0	
Business Owner's Name:	JAY SHULTIS		
Day Phone:	540,250,232	0	
- 4.7 = 121 2121	· · · · · · · · · · · · · · · · · · ·		

To ensure that all required documentation is submitted, please complete the following checklist:				
The requirements for the following drawings & documentation can be waived by the review board only.				
Answered all questions on thi	is form			
State Environmental Quality	Review form (SEQR)			
An estimated project construct dates of significance	ction schedule which includes start-up & completion dates & any interim			
A description of all existing o	or proposed deed restrictions or covenants applying to the property			
Site Plan	Building Plans Color Renderings			
✓ Grading Plan	Detail Plans			
Utilities Plan	Landscape Plans			
Please note:				
A variance from the State of				
Answer the following question	s for all applications. Attach additional paper if necessary.			
THE FACILTY OF AND SET STOPPED ST. STOPPED STO	S TO CONSTRUCT A SINGLE STORY WOOD STORAGE FACILITY ON A VACANT PARCEL. CONSISTS OF (3) IOX20 STORAGE UNITS NG WITH A TOTAL FLOOR AREA OF STRUCTURE WILL BE A MAXIMUM OF THE PEAK AND WILL BE CLAD IN I & ROOFING. (COLOR TBD)			
VIA SOLAR P	ILL NOT HAVE WATER OR ELECTRIC HIS TIME. THE MINIMUM LIGHTING IS PER MYS BUILDING CODE WILL BE OWERED DOWNLIGHTS. AREAS ON THE LOT THAT WILL NOT			
RECEIVE PAV	ING OR BUILDING WILL BE IMPROVED OIL, MULCH & SEED. GRASS WILL BE			

2.	Describe all existing uses of this property:
•;	✓ Vacant Land
	Residential: # of dwelling units:
	Public Assembly:
	Commercial:
	Industrial:
	Other:
3.	Describe all proposed uses of this property: No Change
	Vacant Land
	Residential: # of dwelling units:
	Public Assembly:
	Commercial: (3) SELF STORAGE UNITS
	Industrial:
	Other:
4.	What is the area of all buildings on this lot? This includes, but is not limited to, sheds, carports, decks, stairs, ramps, and pools. a. Before Changes: Square Feet
5.	What is the area of all impervious surfaces on this lot, excluding buildings? An impervious surface is the horizontal area of ground covered by a surface through which water cannot infiltrate. This includes, but is not limited to, sidewalks, patios and asphalt driveways / parking areas.
	a. Before Changes: O Square Feet b. After Changes: 690 Square Feet
6.	Construct new building or addition to existing building: Not Applicable
	a. Area 600 Square Feet b. Height 15 Feet c. # of Stories 1
	d. What is the proposed use of this building / addition (3) SELF STORAGE UNITS
7.	New driveway and/or parking lot:
	a. What will the dimensions of this driveway and/or parking lot be?
	1) Length: 27 Feet 3) Area: 80 Square Feet 2) Width: Feet
8.	Change to existing driveway and/or parking lot: Not Applicable
	a. What will the new dimensions of this driveway and/or parking lot be?
	1) Length: Feet 3) Area: Square Feet 2) Width: Feet

REQUIRED DRAWINGS

You may request a sketch plan conference with the board to review the basic design concept and determine the information to be required on the site plan. If you wish to do so, please complete a sketch plan conference request form.

The drawings do not have to be done by a professional at this time but may be requested at a later date. The drawings can be hand-drawn. It is preferred that any drawings that are hand-drawn be done on graph paper, but are not required to be. All drawings must meet the following criteria: (a) All drawings must include the property address, the title of the drawing, the date the drawing was made, and the name of the person who made the drawing. (b) Drawings must be done with a straight edge and to scale. The scale must be written on the drawing. (c) Multiple drawings cannot be on the same page. (d) Drawings cannot be on paper that is smaller than $8\frac{1}{2}$ " x 11". (e) Drawings done on paper larger than $8\frac{1}{2}$ " x 11" must also be provided in digital format (CD, email, etc). (f) See additional requirements below.

1. Site Plan:

- a. Additional drawing criteria:
 - 1) A North arrow.
 - A scale of 1'' = 50', with 2' contours showing the topography of the lot & areas within 50' of the lot.
- b. One (1) drawing of the entire property:
 - 1) Boundaries of the property and adjoining properties within 200' plotted to scale.
 - 2) Existing watercourses and freshwater wetlands, as identified by the New York State Department of Environmental Conservation and the United States Army Corps of Engineers.
 - 3) Locations and widths of all ingress, egress and circulatory drives and access points to existing roads and highways; locations of all parking and/or truck loading areas.
 - 4) Locations and dimensions for pedestrian and bicycle access, along with existing and proposed circulation patterns and stops for local/regional transit service.
 - 5) Locations for outdoor storage, including refuse, if any.
 - 6) Locations and dimensions of all existing or proposed site improvements, including drains, culverts, retaining walls, sidewalks and fences.
 - 7) Locations of all proposed site and building mounted signs.
 - 8) The location and amount of building area proposed for various uses of the site, including all points of ingress and egress.
 - 9) The location, width and purpose of all existing and proposed easements, setbacks, reservations and areas dedicated to public use on the site(s) and property(ies).
 - 10) Location of vehicle, equipment, and material staging areas, storage and stockpile areas, and other areas to be utilized and disturbed during construction, including the location of portable restroom facilities.
 - 11) Proposed routes and access points for construction traffic.

2. Grading Plan:

- a. One (1) drawing of the entire property:
 - A grading plan showing existing and proposed contours, including spot elevations along structures and site improvements where appropriate to determine the flow of surface runoff. The inclusion of arrows denoting surface flow direction is also preferred where appropriate.

- 2) Line(s) denoting limits of disturbance, clearing, grubbing, and grading as appropriate. Protective fencing for areas and vegetation to be preserved and undisturbed throughout construction shall also be shown.
- 3) Documents and plans pursuant to the requirements of the New York State Pollution Discharge Elimination System (SPDES), including a completed Storm Water Pollution Prevention Plan (SWPPP) for Zoning Board review.
- 4) Construction management plan and an inspection schedule as required by the Code Enforcement Officer.

3. Utilities Plan:

- a. One (1) drawing of the entire property:
 - The locations and size of water, sanitary sewer and storm sewer lines and appurtenances and connections to utility services, including all invert and grate elevations. Where possible, the inclusion of arrows denoting the flow of storm and sanitary sewers is preferred.
 - 2) Locations of fire and other emergency zones, including the location of fire hydrants and building sprinkler system connection points.
 - 3) Locations of all fuel and energy exploration, generation, transmission, distribution and storage facilities, including but not limited to electricity, natural gas, propane, motor vehicle fuels, and wind, solar and geothermal energy systems
 - 4) Locations of outdoor lighting facilities, including the locations of poles, bollards, and building mounted fixtures. Where appropriate and upon request, a photometric plan shall also be prepared and submitted for review and approval by the Zoning Board and Code Enforcement Officer.
 - 5) Locations of telephone, cable and other telecommunications devices and facilities.

4. Building Plans:

- a. One (1) drawing of the entire property:
 - 1) Floor plans showing the location of all building ingress and egress points.
 - 2) Elevation plans denoting the type of construction and construction materials, and exterior dimensions of all building elements and facades. Building elevations shall include structures on adjoining lots to indicate the scale and massing of the proposed structure in relation to the area.

5. Detail Plans:


- a. One (1) drawing of the entire property:
 - 1) The design dimensions and type of construction of all driveways, parking areas and/or loading areas.
 - 2) The design and construction materials of all proposed site improvements, including drains, culverts, retaining walls and fences.
 - 3) The design and construction materials to be used for all water and sewer lines and appurtenances.
 - 4) The design of all fire hydrants.
 - 5) The design and construction materials of all fuel and energy exploration, generation, transmission, distribution and storage facilities.
 - 6) The design dimensions, type of construction materials, including illumination, of all proposed signs.
 - 7) The design and construction, including dimensions, of outdoor lighting facilities and the area of illumination on subject and adjacent properties.


6.	,	Landscape	Plans:
----	---	-----------	--------

- a. One (1) drawing of the entire property:
 - 1) The location and dimensions of proposed buffers, screening and fence areas specifying materials and vegetation; include existing vegetative cover and proposed areas of lawn and groundcover.
 - 2) A general landscaping plan and planting schedule specifying types and size of vegetation. The size of vegetation at installation and upon maturity shall be noted on the plans.
- 7. Color Renderings

Tax Map #:		Zoning Dis	strict:		
Planning Commission Meeting Date:					
Site Plan Review Application:	Approved	Denied	Withdrawn By Applicant		
SEQR Application:	Approved	Denied	Not Required		

FOR CODE ENFORCEMENT OFFICE USE ONLY

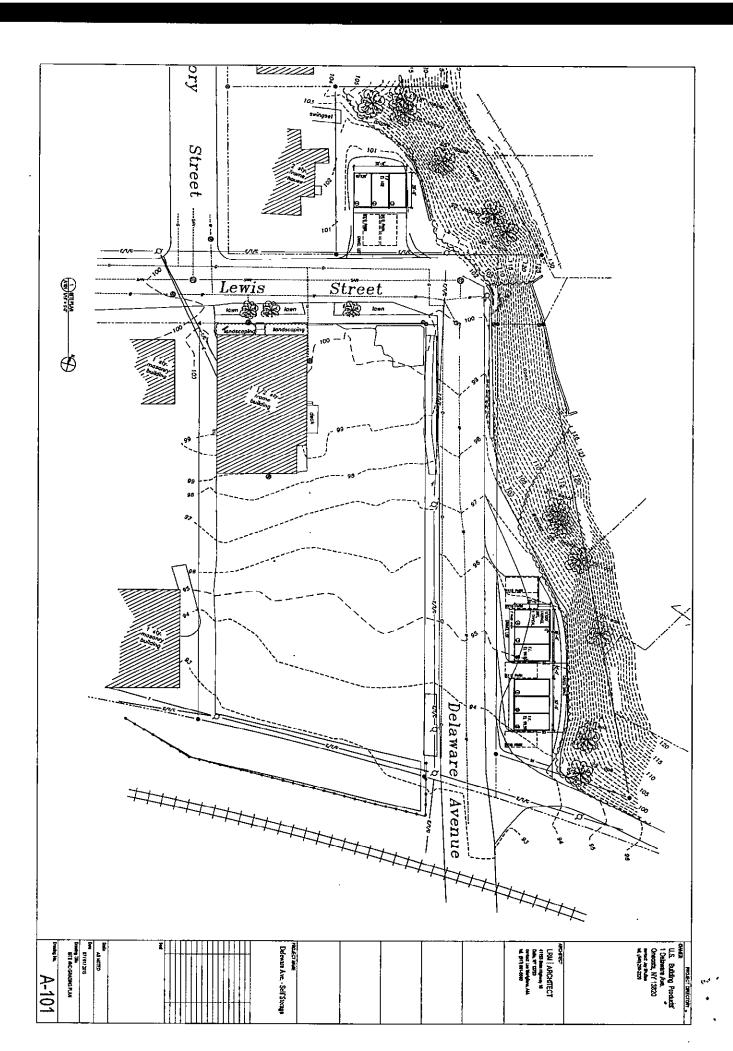

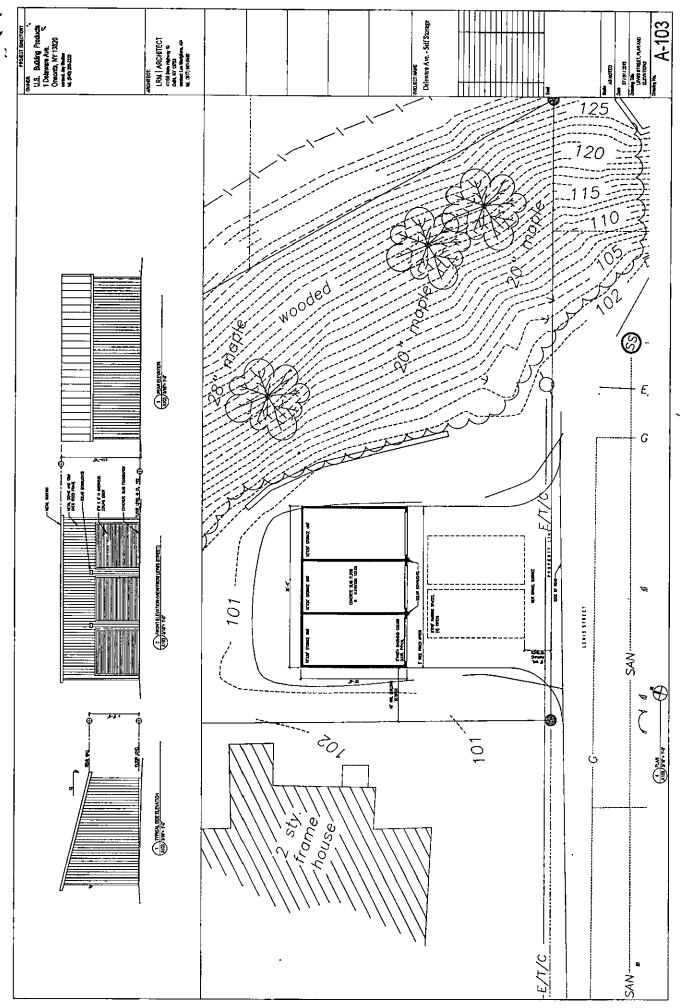

- ' '